### MIAMI-DADE COUNTY PROCESS NO.: E24-021 DATE: NOV 7 2024 DEPARTMENT OF REGULATORY BY: ISA AND ECONOMIC RESOURCES APPLICATION FOR ENTRANCE FEATURE DEVELOPMENT SERVICES DIVISION 111 N.W. 1<sup>ST</sup> STREET, 11<sup>TH</sup> FLOOR MIAMI, FL 33128 PH. (305) 375-2141 E2024000021 Entrance Feature No.: Tentative No.: Plat Name Twp. Sec. Rge. RIGHT-OF-WAY OF ASSOCIATION ENTRANCE SW 124TH STREET Property Location: BETWEEN 96TH AND 97TH AVENUE, MIAMI, FLORIDA 33176 EU-M SINGLE FAMILY ESTATE Zoning: MODIFIED USE ZONING DISTRICT District: Owner: OAK RIDGE ASSOCIATION Owner's Email: kelly@fostercompany.net RIGHT-OF-WAY OF ASSOCIATION ENTRANCE SW 124TH STREET Owner's Address: BETWEEN 96TH AND 97TH AVENUE, MIAMI, FLORIDA 33176 Owner's Phone: 305-254-7228 x: 204 Frank Anaya Contact person: info@olympus-cm.com Contact's Email: 1429 SW 1st Street 1st Floor, Miami FL 33135 Contact's Address: Contact's Phone: 786-484-6674

Please note that this application must be submitted to the Department of Regulatory and Economic Resources on the 11<sup>Th</sup> floor with the processing check made payable to the "Miami-Dade County".

FOR OF	FFCIAL US	E ONLY
Check No:		
Bank:		
Date received:		

Rev. 2017-10-17

## IRIECIEIIVIEID

### MIAMI-DADE COUNTY **ZONING APPLICATION FOR ADMINISTRATIVE** PROCESS NO.: E24-021 **APPROVAL OF ENTRANCE FEATURE** DATE: NOV 7 2024

**MIAMI-DADE COUNTY** 

E2024000021

Sec. \_\_\_\_\_ Twp. \_\_\_\_\_ Rge. \_\_\_\_\_

Fee: \_\_\_\_\_

BY: ISA

FOLIO# 30- 30-5016-0610-450

Date Received Stamp

This application with all required supplemental data, information and <u>fee must be completed</u> in accordance with the attached "INSTRUCTIONS FOR FILING APPLICATION FOR ENTRANCE FEATURE" and returned to the MIAMI-DADE COUNTY DEPARTMENT OF REGULATORY AND ECONOMIC RESOURCES, the Zoning Hearings Section.

TYPE OR PRINT LEGIBLY ALL INFORMATION ON APPLICATION:

1)	Applicant Olympus Construction Management		Phone	7864846674
	Mailing Address 1429 SW 1st Street 1st Floor, Cit	ty Miami Sta	ate <u>FL</u>	Zip <u>33135</u>
	Email Address info@olympus-cm.com			
2)	Owner of Property OAK RIDGE ASSOCIATION		Phone	<u>305-254-7228 x:</u> 204
	Mailing Address 9600 SW 124 Street Cit	ty <u>MIAMI</u> Sta	ate <u>FL</u>	Zip <u>33176</u>
	Email Address kelly@fostercompany.net			
3)	Contact Person <u>Frank Anaya</u> Mailing Address <u>1429 SW 1st Street 1st Floor,</u> Cit	ty <u>MIAMI</u> Sta		7864846674 Zip <u>33135</u>
	Email Address info@olympus-cm.com			
4)	LEGAL DESCRIPTION OF THE PROPERTY CO	OVERED BY THE	APPLICATI	ON:
	<u>GHT-OF-WAY OF ASSOCIATION ENTRANCE SW 124</u> ENUE, MIAMI, FLORIDA 33176	TH STREET BET	WEEN 96TH /	AND 97TH

5) SIZE OF PROPERTY: <u>9400</u> x <u>SFT</u>

6) Address or location of subject property 9600 SW 124 Street

7) Present Zoning Classification(s) EU-M SINGLE FAMILY ESTATE MODIFIED USE ZONING DISTRICT

8) Is this Entrance Feature being requested as a result of a violation notice or summons? <u>NO</u>

# OAK RIDGE ESTATES II ENTRANCE IMPROVEMENTS

# SUBMITTAL GRAPHIC SYMBOLS

NEW	
REVISED	X
RE-ISSUED WITHOUT REVISION	
PREVIOUSLY SUBMITTED	

0	NAME OF PROJECT:
90 M	LOCATION:
0	OWNER:
RI	USE:
FL FL FL	CODE ENFORCEMENT JURISDICTION:

# **ZONING DATA**

ZONING DISTRICT: FOLIO NUMBER:



### NOMAD ARCHITECTURAL STUDIO

RAUL CRUZ, AIA, NCARB ARCHITECT

(786) 738-7895 rcruz@nomadarchitecturalstudio.com

# INDEX OF DRAWINGS

### ARCHITECTURAL

A001	COVER
A002	MICROFILMS
A101	SITE PLAN
A201	GUARDHOUSE
A301	GATES
A401	TRELLIS

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9600 SW 124TH STREET, MIAMI, FLORIDA 33176

# PROJECT GENERAL DATA & CODE SUMMARY

OAK RIDGE ESTATES II ENTRANCE IMPROVEMENTS

9600 SW 124TH STREET, MIAMI, FLORIDA 33176

OAK RIDGE ASSOCIATION

RESIDENTIAL

FLORIDA FIRE PREVENTION CODE 2023 (FFPC) 8TH EDITION FLORIDA BUILDING CODE (FBC) 8TH EDITION (2023) LORIDA BUILDING CODE RESIDENTIAL 2023 (FBCR) 8TH EDITION NFPA 1, 2021 EDITION, "FIRE CODE" NFPA 101, 2018 EDITION, "LIFE SAFETY CODE" MIAMI DADE COUNTY ZONING CODE

EU-M SINGLE FAMILY ESTATE MODIFIED USE ZONING DISTRICT

30-5016-061-0450



SW 121ST STREET

SW 123RD TERRACE

SW 124TH TERRACE  SW 124TH STREE


SW 123RD STREET


SW 122ND STREET\_\_\_


### OLYMPUS CONSTRUCTION MANAGEMENT


FRANK ANAYA, P.E. GENERAL CONTRACTOR


(786) 484-6674 fanaya@olympus-cm.com

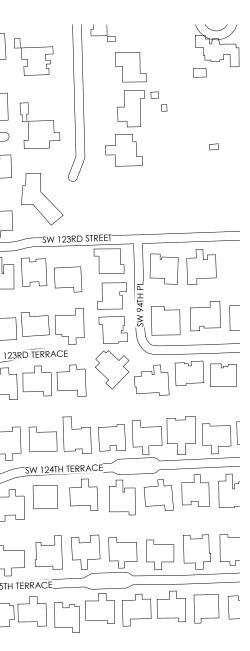

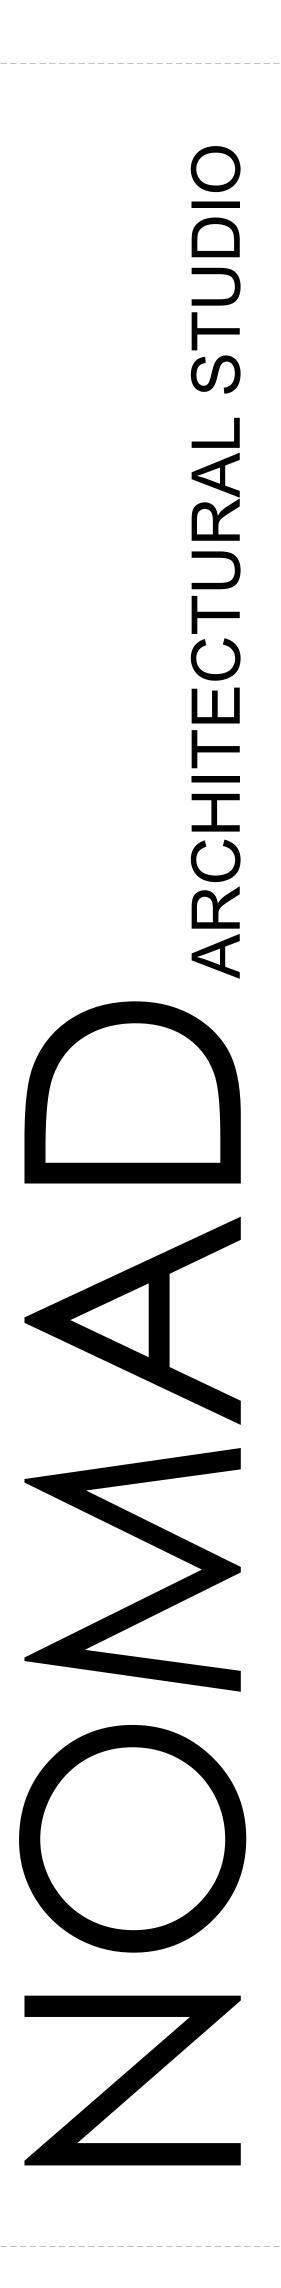

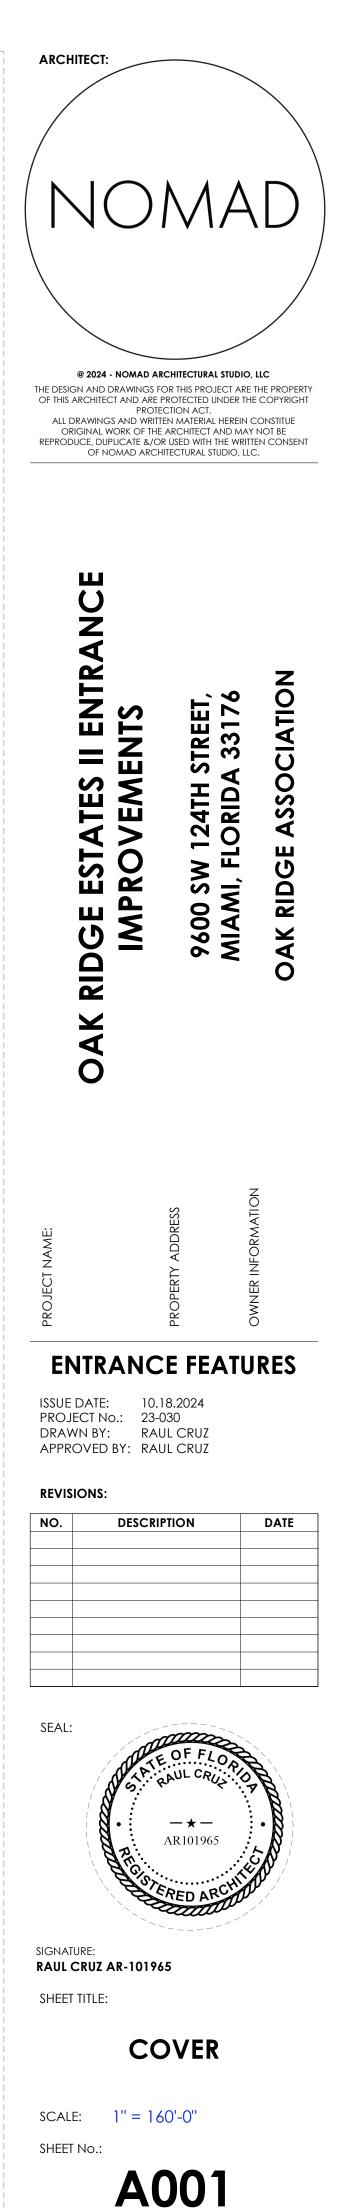

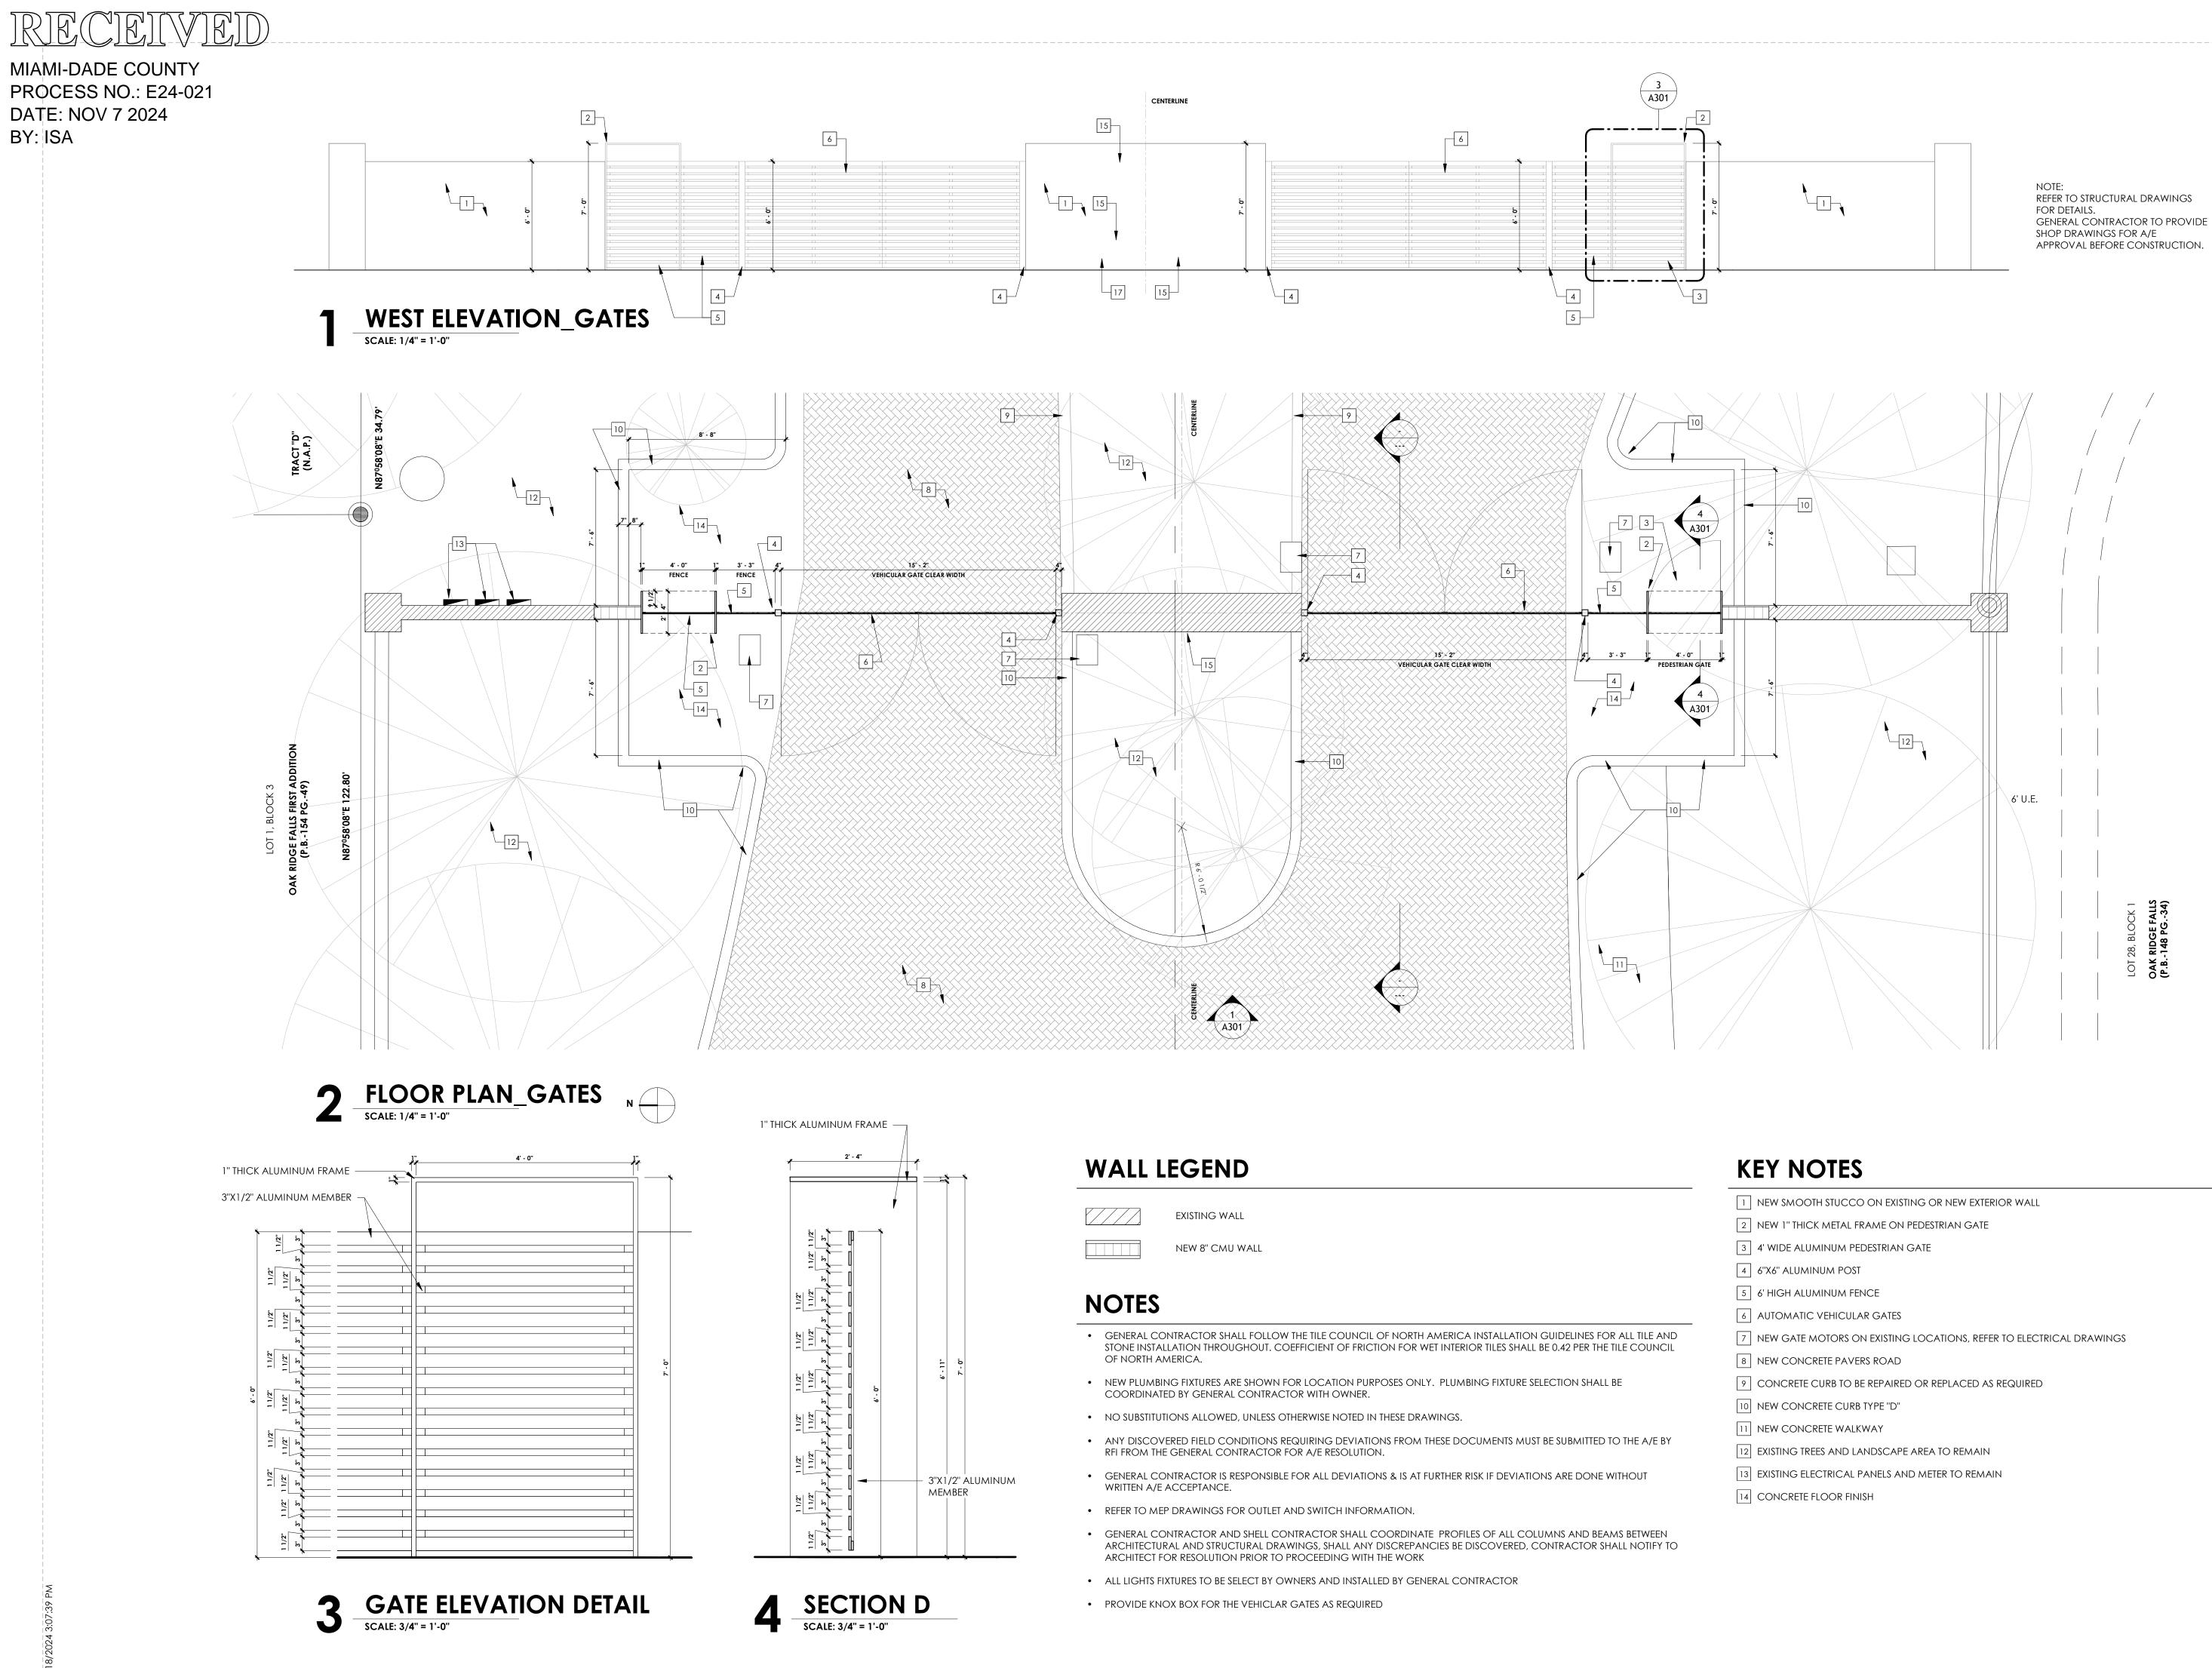

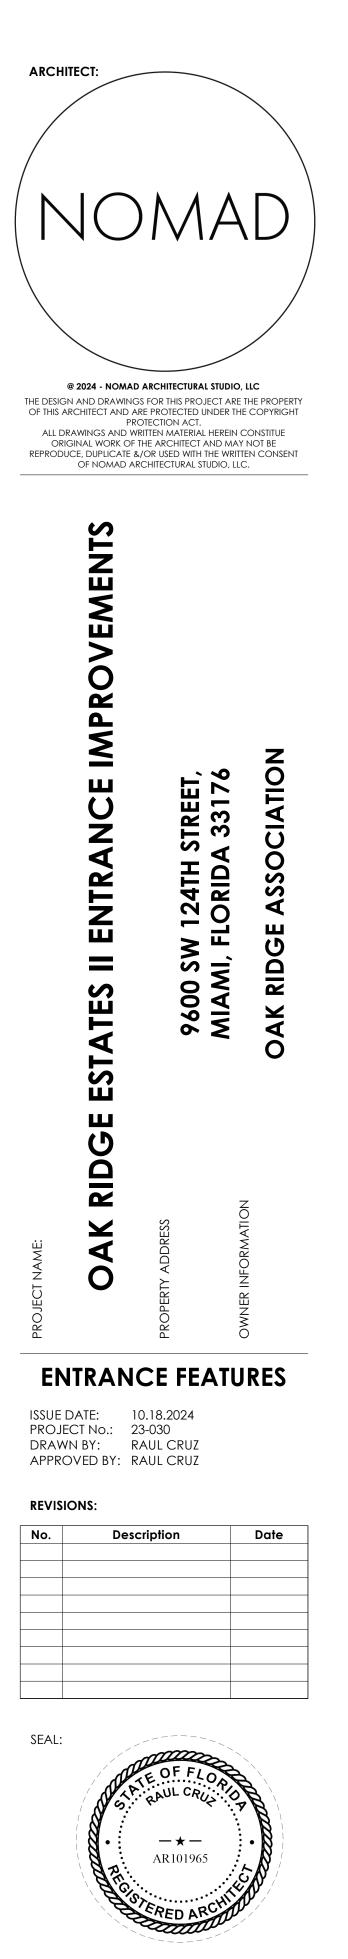


signature: RAUL CRUZ AR-101965


SHEET TITLE:

GATES

SCALE: As indicated SHEET NO.:



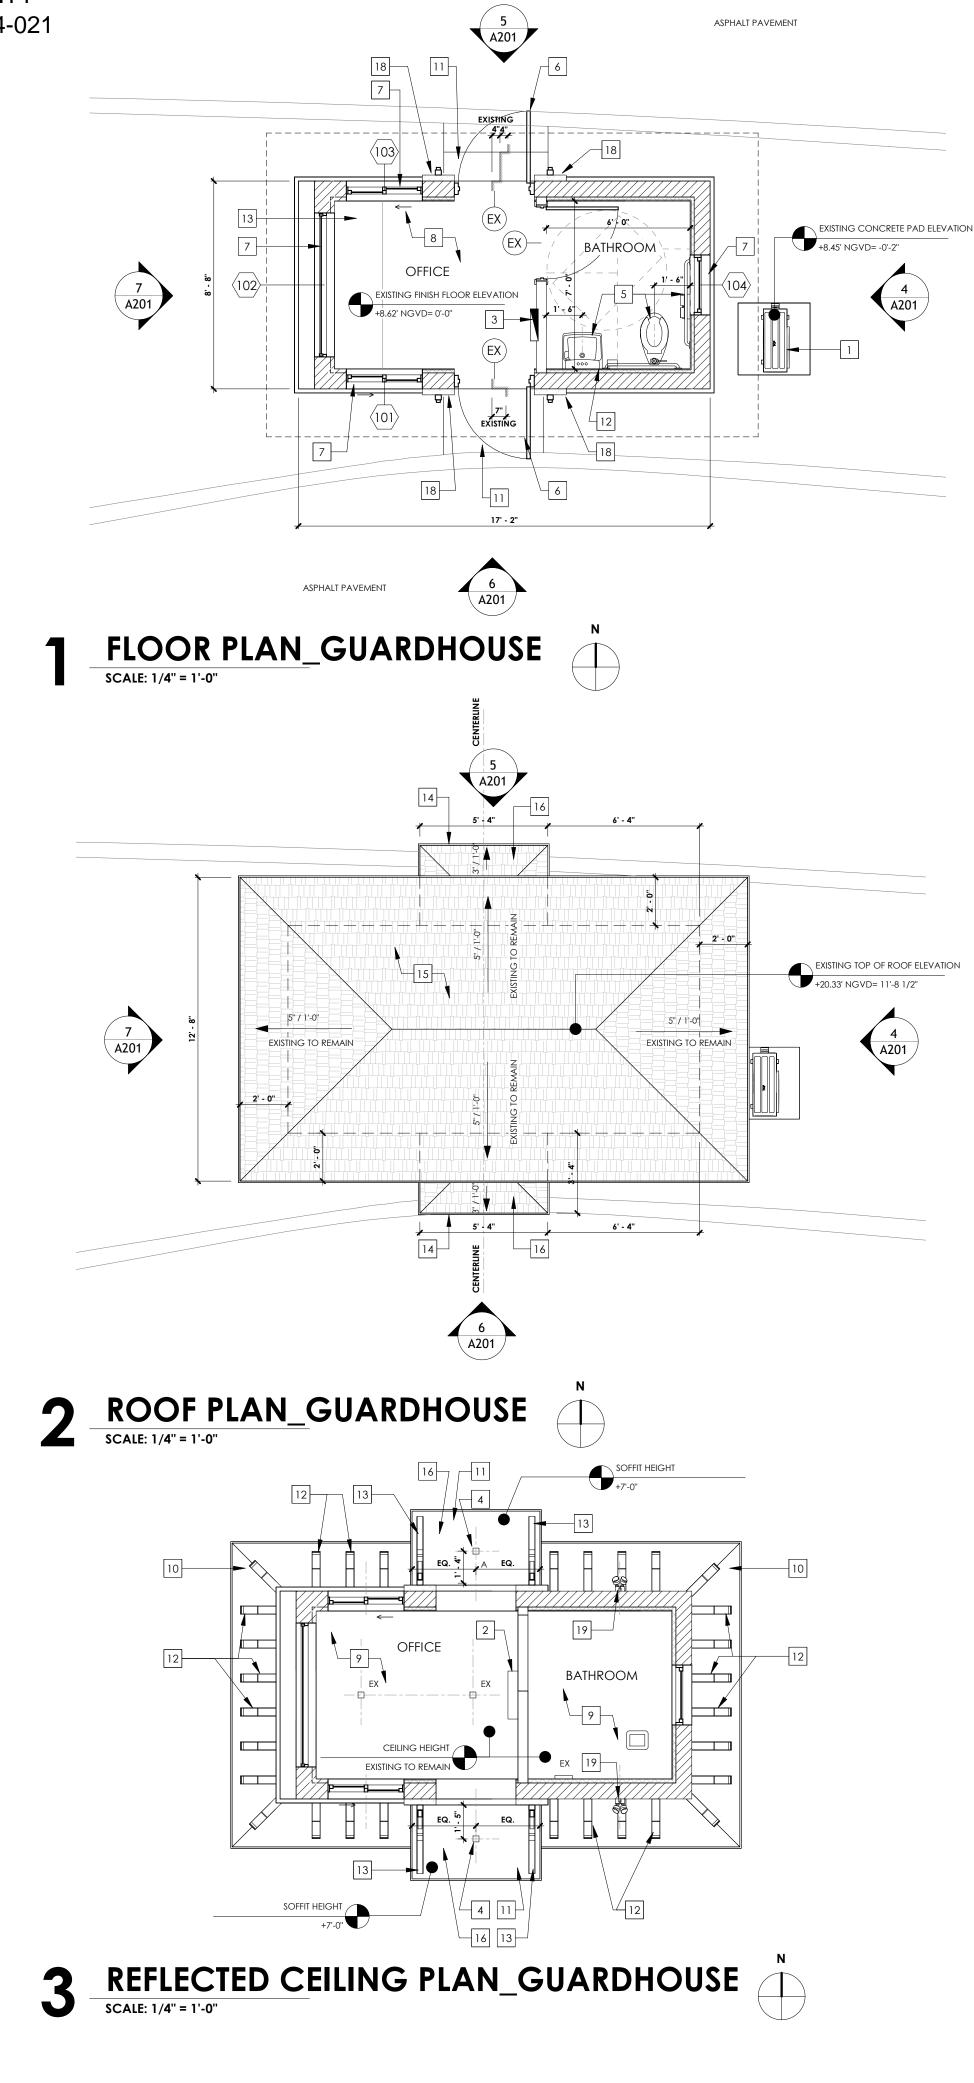


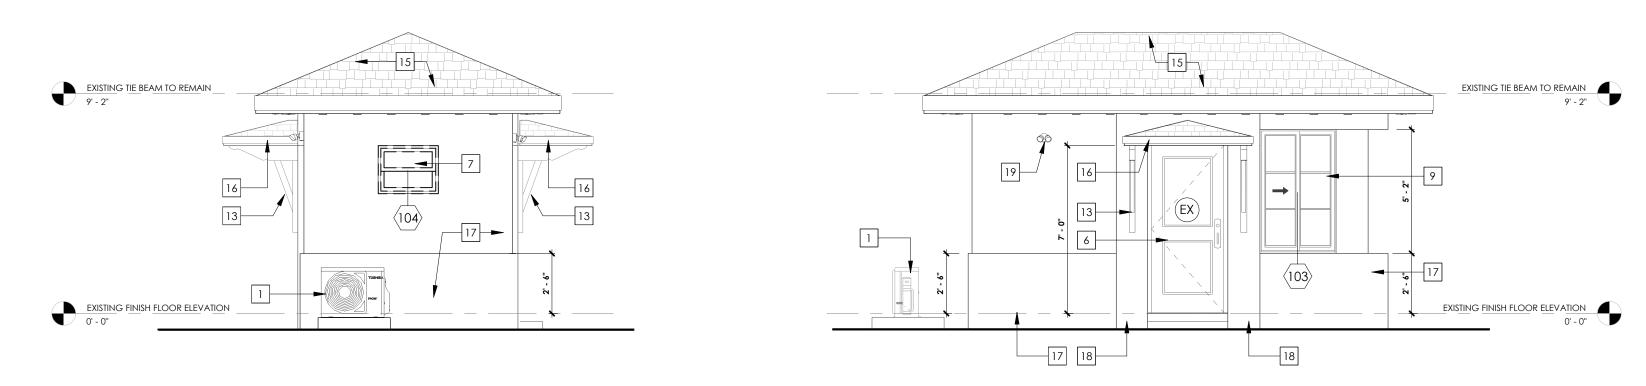

5

SCALE: 1/4" = 1'-0"



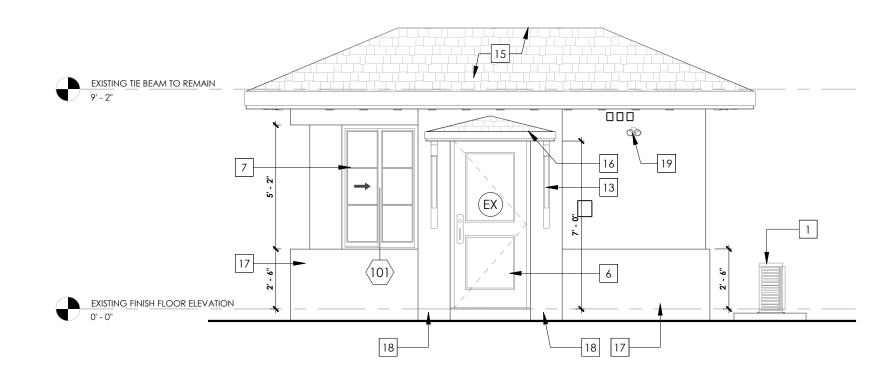



## NOTES

- ALL GLASS USED SHALL BE CAT. II SAFETY GLASS.
- PROVIDE DUROCK AT ALL INTERIOR STONE OR TILE AREA INSTALLATION.
- GENERAL CONTRACTOR SHALL FOLLOW THE TILE COUNCIL OF NORTH AMERICA INSTALLATION GUIDELINES FOR ALL TILE AND STONE INSTALLATION THROUGHOUT. COEFFICIENT OF FRICTION FOR WET INTERIOR TILES SHALL BE 0.42 PER THE TILE COUNCIL OF NORTH AMERICA.
- NEW PLUMBING FIXTURES ARE SHOWN FOR LOCATION PURPOSES ONLY. PLUMBING FIXTURE SELECTION SHALL BE COORDINATED BY GENERAL CONTRACTOR WITH OWNER.
- GC IS RESPONSIBLE FOR COORDINATING ALL WIRING/DATA WITH MILLWORK MANUFACTURER.
- NO SUBSTITUTIONS ALLOWED, UNLESS OTHERWISE NOTED IN THESE DRAWINGS.
- ANY DISCOVERED FIELD CONDITIONS REQUIRING DEVIATIONS FROM THESE DOCUMENTS MUST BE SUBMITTED TO THE A/E BY RFI FROM THE GENERAL CONTRACTOR FOR A/E RESOLUTION.
- GENERAL CONTRACTOR IS RESPONSIBLE FOR ALL DEVIATIONS & IS AT FURTHER RISK IF DEVIATIONS ARE DONE WITHOUT WRITTEN A/E ACCEPTANCE.
- REFER TO MEP DRAWINGS FOR OUTLET AND SWITCH INFORMATION.
- GENERAL CONTRACTOR AND SHELL CONTRACTOR SHALL COORDINATE PROFILES OF ALL COLUMNS AND BEAMS BETWEEN ARCHITECTURAL AND STRUCTURAL DRAWINGS, SHALL ANY DISCREPANCIES BE DISCOVERED, CONTRACTOR SHALL NOTIFY TO ARCHITECT FOR RESOLUTION PRIOR TO PROCEEDING WITH THE WORK
- FOAM PLASTIC OR FOAM PLASTIC CORES USED AS A COMPONENT IN MANUFACTURED ASSEMBLIES USED IN BUILDING CONSTRUCTION SHALL HAVE A FLAME SPREAD INDEX OF NOT MORE THAN 75 AND SHALL HAVE A SMOKE-DEVELOPED INDEX OF NOT MORE THAN 450 WHEN TESTED IN THE MAXIMUM THICKNESS AND DENSITY INTENDED FOR USE IN ACCORDANCE WITH ASTM E84 OR UL 723. FBC 316 11.
- FIRE BLOCKING SHALL BE PROVIDED IN WALLS EVERY 10' HORIZONTALLY AND AT CEILINGS/FLOORS LEVEL, INTERCONNECTIONS, BETWEEN STAIR STRINGERS, AT OPENINGS, AT FLOOR JOISTS, AROUND POCKET DOORS. FBC 302.11(1-6)
- WALL AND CEILING FINISHES SHALL HAVE A FLAME SPREAD INDEX OF NOT GREATER THAN 200 AND SHALL HAVE A SMOKE-DEVELOPED INDEX OF NOT GREATER THAN 450 AS PER ASTM E84 OR UL 723. 2023 FBC, 8TH EDITION SECTION R302.9.
- INSULATION MATERIALS, INCLUDING FACINGS, SUCH AS VAPOR RETARDERS AND VAPOR-PEMEABLE MEMBRANES INSTALLED WITHIN FLOOR-CEILING ASSEMBLIES, ROOF-CEILINGASSEMBLIES, WALL ASSEMBLIES, CRAWL SPACES AND ATTICS SHALL HAVE A FLAME SPREAD INDEX NOT TO EXCEED 25 WITH AN ACCOMPANYING SMOKE-DEVELOPED INDEX NOT TO EXCEED 450 WHERE TESTED IN ACCOORDANCE WITH ASTM E84 OR UL 723. 2023 FBC, 8TH EDITION SECTION R302.10.
- NEW ROOFING SHALL BE UNDER A SEPARATE PERMIT
- FIBER-CEMENT, FIBER-MAT REINFORCED CEMENTITIOUS BACKER UNITS, GLASS MAT GYPSUM BACKERS AND FIBER-REINFORCED GYPSUM BACKERS, PER STANDARDS, AND INSTALLED PER MANUFACTURER'S RECOMMENDATIONS, SHALL BE USED AS BACKERS FOR WALL TILE IN TUB AND SHOWER AREAS AND WALL PANELS IN SHOWER AREAS -FBC 702.4.2
- ALL FINISH ON G.W.B. CEILING SHALL BE SMOOTH LEVEL (5)
- ALL ELECTRICAL CONDUIT RUNS FOR EXTERIOR LIGHTING SHALL BE CONCEALED
- REFER TO ELECTRICAL DRAWINGS FOR SMOKE DETECTOR LOCATIONS. DETECTORS SHALL BE SMOKE AND CARBON MONOXIDE COMBINATION.
- ALL LIGHTS FIXTURES TO BE SELECT BY OWNERS AND INSTALLED BY GENERAL CONTRACTOR



SCALE: 1/4" = 1'-0"

# WALL LEGEND


EXISTING EXTERIOR OR DUROCK, REFE
EXISTING INTERIOR

## **KEY NOTES**

	EXISTING HVAC COMPRESSOR OVER EXISTING CONCR
2	EXISTING INTERIOR HVAC WALL MOUNTED SPLIT UNIT T
3	EXISTING ELECTRICAL PANEL TO REMAIN, REFER TO ELE
1	NEW EXTERIOR SOFFIT MOUNTED LIGHT
5	EXISTING PLUMBING FIXTURES TO REMAIN
5	EXISTING DOOR TO REMAIN
7	NEW IMPACT RATED WINDOW IN EXISTING OPENING, I
3	NEW FINISH FLOOR MATERIAL OVER EXISTING SLAB ON
>	EXISTING CEILING TO REMAIN
0	EXISTING WOOD SOFFIT TO REMAIN AND REPAIRED AS
1	NEW WOOD SOFFIT TO MATCH EXISTING
2	EXISTING WOOD RAFTERS TO REMAIN
3	NEW WOOD BRACKETS, REFER TO DETAILS
4	PROVIDE NEW FASCIA, REFER TO OVERHANG DETAIL
5	EXISTING ROOF STRUCTURE TO REMAIN, NEW CONCRE
6	NEW ENTRY ROOF STRUCTURE WITH CONCRETE FLAT TH
7	NEW SMOOTH STUCCO OVER EXISTING EXTERIOR WAL
8	PROVIDE NEW FRAME WITH SMOOTH STUCCO FINISH

19 RELOCATED EXTERIOR LIGHT, REFER TO ELECTRICAL DRAWINGS

NORTH ELEVATION\_GUARDHOUSE

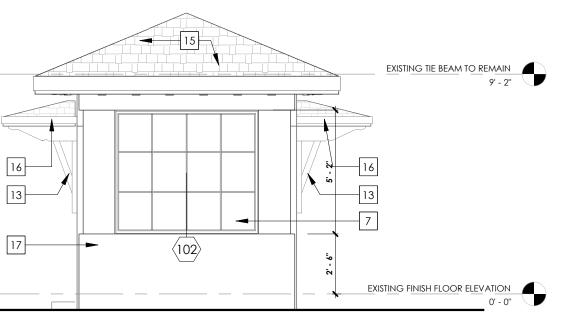

# WEST ELEVATION\_GUARDHOUSE

R CMU WALL WITH NEW OR EXISTING INTERIOR METAL FURRING AND GYPSUM WALL BOARD ER TO WALL TYPES

R PARTITION

EXISTING HVAC COMPRESSOR OVER EXISTING CONCRETE PAD TO REMAIN

NOUNTED SPLIT UNIT TO REMAIN

EMAIN, REFER TO ELECTRICAL DRAWINGS

EXISTING OPENING, REFER TO WINDOW SCHEDULE AND ELEVATIONS PREXISTING SLAB ON GRADE

IN AND REPAIRED AS NEEDED

MAIN, NEW CONCRETE FLAT TILE TO BE INSTALLED


TH CONCRETE FLAT TILE TO BE INSTALLED


STING EXTERIOR WALL (TYPICAL)




# IRIECIEIVIEID

MIAMI-DADE COUNTY PROCESS NO.: E24-021 DATE: NOV 7 2024 BY: ISA

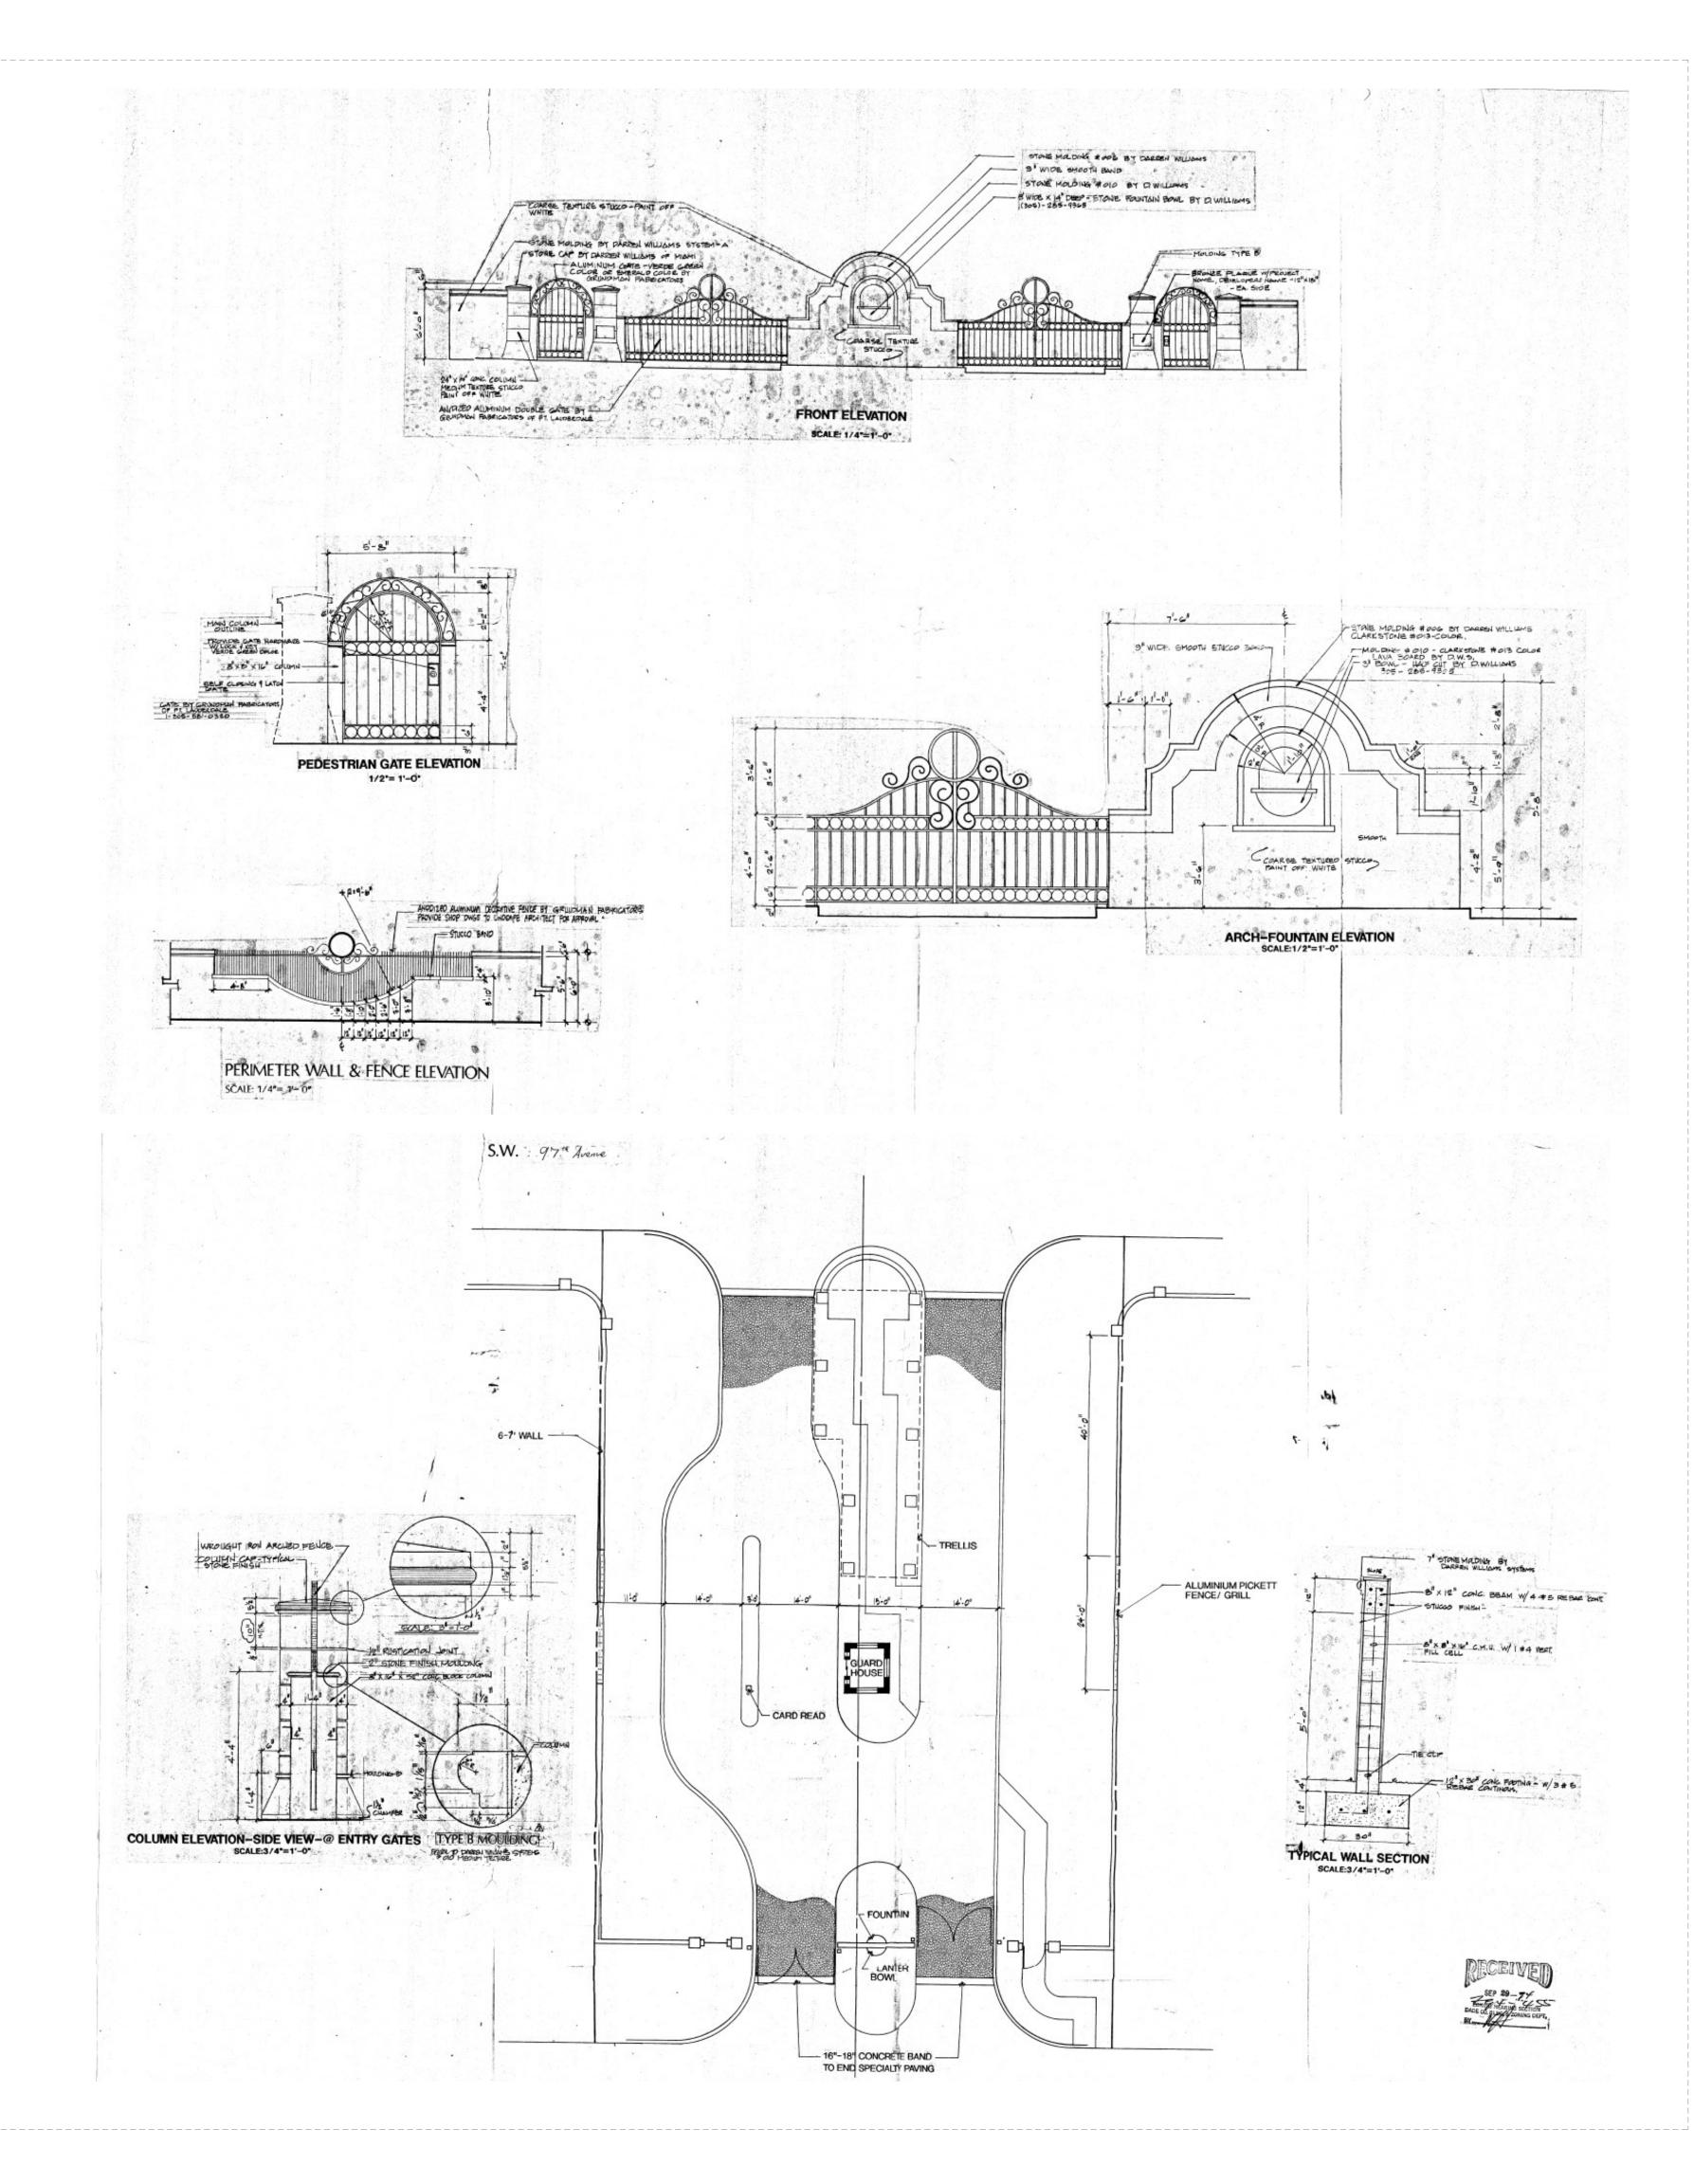

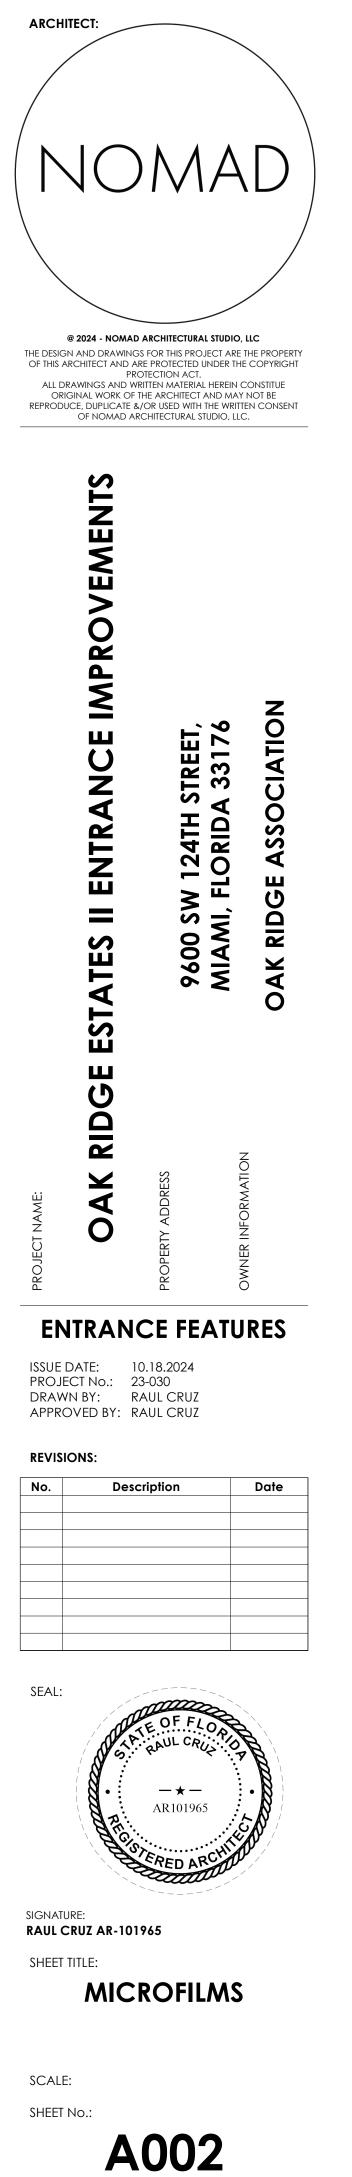

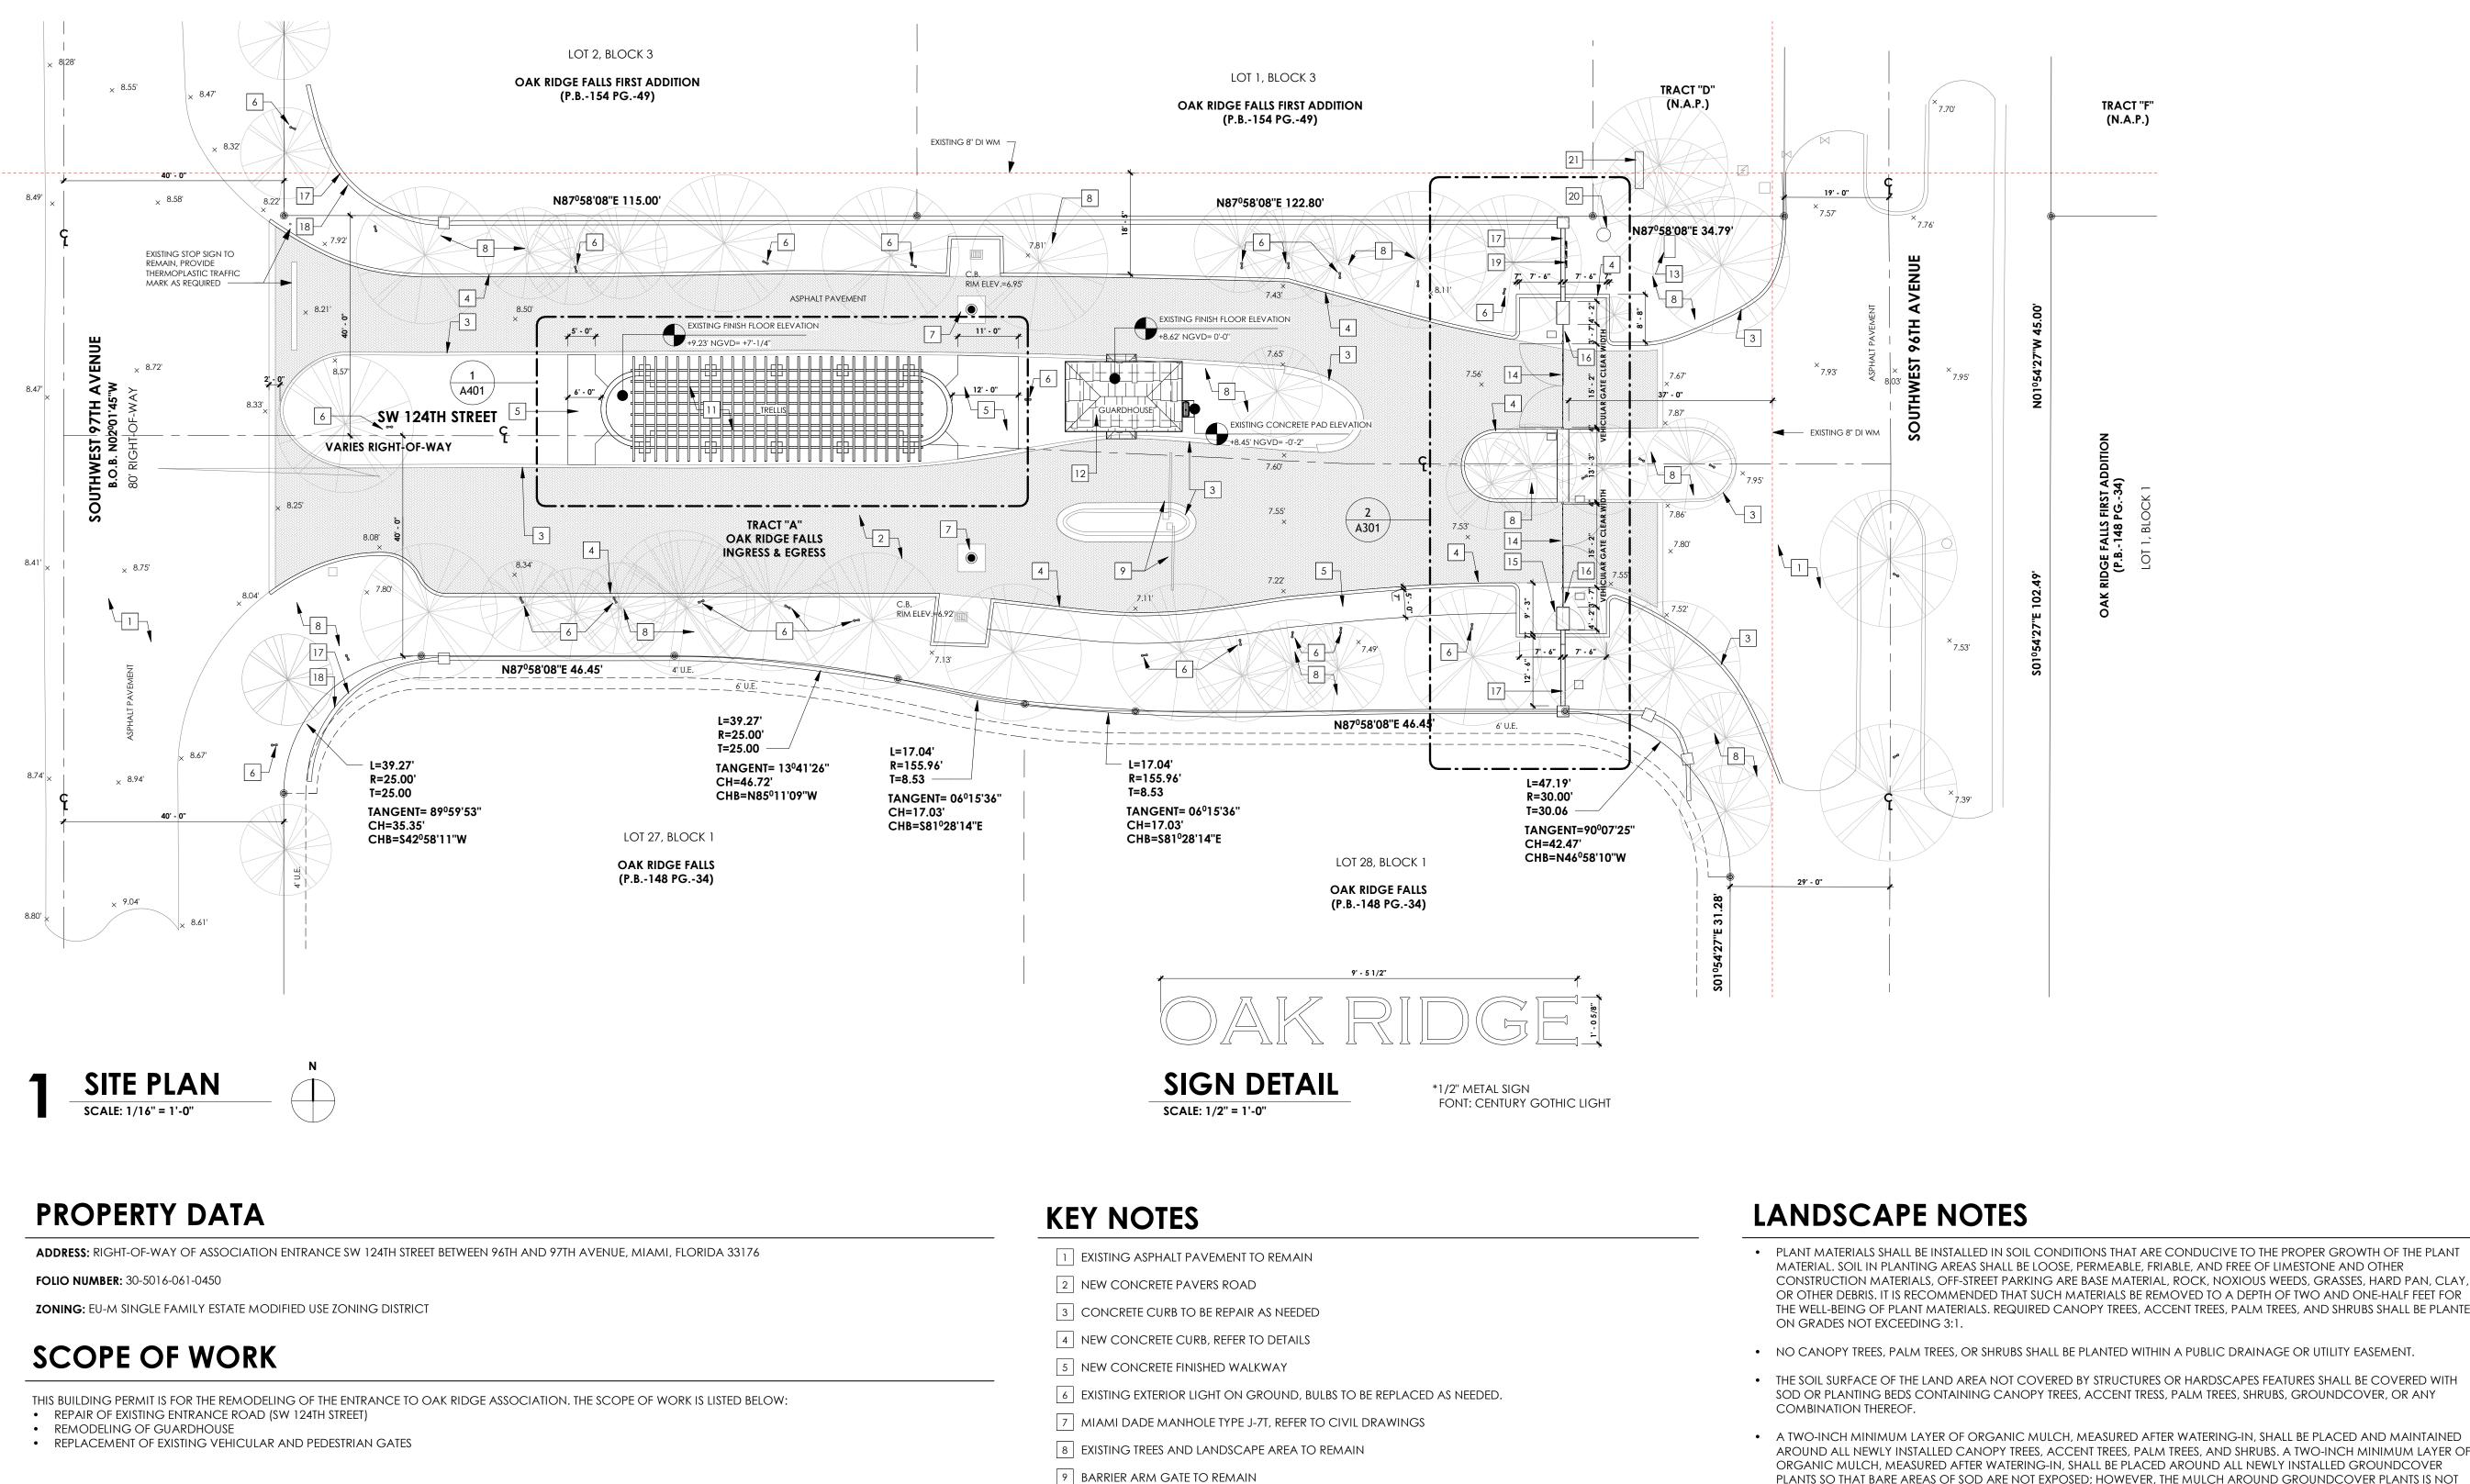

BASE FLOOD ELEVATION: 10.0' NGVD

# **FLOOD LEGEND**

- FLOOD ZONE: AH
- MAP & PANEL NUMBER: 120635L0461 COMMUNITY NUMBER: 120635
- HIGHEST CROWN OF ROAD ELEV.: +9.04' (NGVD) LOWEST CROWN OF ROAD ELEV: +7.41' (NGVD)
- (CROWN OF ROAD ELEVATION WAS TAKEN FROM THE ATTACHED SURVEY) THE ATTACHED CERTIFIED SURVEY: JOHN IBARRA PSM LIC. # 5204
- SURVEYORS NAME +8.62' (NGVD)
- HIGHEST EXISTING FINISH FLOOR ELEVATION:
- LOWEST FLOOR ELEVATION: +8.62' (NGVD)
- LOWEST ELEVATION OF EQUIPMENT SERVICING THE BUILDING: +8.45' (NGVD)
- 0'-0" = <u>+8.62</u> NGVD (EXISTING GUARDHOUSE FLOOR ELEVATION TO REMAIN)

# SITE GENERAL NOTES

 GENERAL CONTRACTOR SHALL FILL SITE AS REQUIRED TO MEET ALL NEW SITE ELEVATIONS

# SITE INVESTIGATION NOTE

BEFORE BIDDING, CONTRACTOR SHALL PERFORM A THOROUGH INVESTIGATION OF THE ACTUAL CONDITIONS AT THE JOB SITE, AND INCLUDE ALL WORK REQUIRED TO GET THE JOB DONE AS INDICATED ON DRAWINGS OR NECCESSITATED BY THE CONSTRUCTION, PERFORM ALL SUCH WORK WITHOUT ADDITION TO THE CONTRACT COST.

11 EXISTING TRELLIS UNDER A SEPARATE PERMIT, REFER TO SHEET A401 FOR DETAILS

- 12 GUARDHOUSE, REFER TO SHEET A201 FOR DETAILS
- 13 EXISTING GENERATOR TO REMAIN

10 NOT USED

- 14 NEW AUTOMATIC VEHICULAR GATE. PROVIDE KNOX BOX AS REQUIRED, REFER TO SHEET A301 FOR DETAILS
- 15 NEW PEDESTRIAN GATE, REFER TO SHEET A301 FOR DETAILS
- 16 NEW FENCE, REFER TO SHEET A301 FOR DETAILS
- EXISTING WALL TO BE REFINISHED WITH SMOOTH STUCCO AND PAINTED USING EXTERIOR PAINT, COLOR TO BE SELECTED BY OWNER
- 18 REPLACE EXISTING OAK RIDGE SIGN, REFER TO DETAIL
- 19 EXISTING ELECTRICAL PANELS AND METER TO REMAIN
- 20 EXISTING IRRIGATION PUMP TO REMAIN
- 21 EXISTING GAS TANK TO REMAIN

 PLANT MATERIALS SHALL BE INSTALLED IN SOIL CONDITIONS THAT ARE CONDUCIVE TO THE PROPER GROWTH OF THE PLANT MATERIAL. SOIL IN PLANTING AREAS SHALL BE LOOSE, PERMEABLE, FRIABLE, AND FREE OF LIMESTONE AND OTHER CONSTRUCTION MATERIALS, OFF-STREET PARKING ARE BASE MATERIAL, ROCK, NOXIOUS WEEDS, GRASSES, HARD PAN, CLAY, OR OTHER DEBRIS. IT IS RECOMMENDED THAT SUCH MATERIALS BE REMOVED TO A DEPTH OF TWO AND ONE-HALF FEET FOR THE WELL-BEING OF PLANT MATERIALS. REQUIRED CANOPY TREES, ACCENT TREES, PALM TREES, AND SHRUBS SHALL BE PLANTED

NO CANOPY TREES, PALM TREES, OR SHRUBS SHALL BE PLANTED WITHIN A PUBLIC DRAINAGE OR UTILITY EASEMENT.

• THE SOIL SURFACE OF THE LAND AREA NOT COVERED BY STRUCTURES OR HARDSCAPES FEATURES SHALL BE COVERED WITH SOD OR PLANTING BEDS CONTAINING CANOPY TREES, ACCENT TRESS, PALM TREES, SHRUBS, GROUNDCOVER, OR ANY

AROUND ALL NEWLY INSTALLED CANOPY TREES, ACCENT TREES, PALM TREES, AND SHRUBS. A TWO-INCH MINIMUM LAYER OF ORGANIC MULCH, MEASURED AFTER WATERING-IN, SHALL BE PLACED AROUND ALL NEWLY INSTALLED GROUNDCOVER PLANTS SO THAT BARE AREAS OF SOD ARE NOT EXPOSED; HOWEVER, THE MULCH AROUND GROUNDCOVER PLANTS IS NOT REQUIRED TO BE MAINTAINED AFTER THE GROUNDCOVER BECOMES ESTABLISHED. EXCEPT AS OTHERWISE PROVIDED IN THESE REGULATIONS, EACH CANOPY TREE, ACCENT TREE, AND PALM TREE SHALL HAVE ORGANIC MULCH NO LESS THAN 36 INCHES BEYOND ITS TRUNK IN ALL DIRECTIONS; HOWEVER, THE MULCH SHALL BE KEPT AWAY FROM THE TRUNKS AND STEMS OF PLANTS SO AS TO AVOID CONDITIONS THAT MAY BE CONDUCIVE TO COLLAR ROT, BASAL CANKER, OR OTHER FUNGI. THE USE OF CYPRESS OR CEDAR MULCH IS STRONGLY DISCOURAGED.

• THE RIGHT-OF-WAY FROM THE EDGE OF THE STREET PAVEMENT TO THE PROPERTY LINE SHALL BE PLANTED WITH SOD OR OTHER

IRRIGATION SYSTEM IS NOT PROVIDED UNDER THIS PERMIT


APPROVED GROUNDCOVERS.

• ALL PLANTS FURNISHED BY THE LANDSCAPE CONTRACTOR UNLESS OTHERWISE SPECIFIED SHALL BE FLORIDA NO.1 OR BETTER, AND SHALL BE SPECIFIED IN GRADES AND STANDARDS FOR NURSERY PLANTS, PART 1 (3RD EDITION, 1975) BY THE FLORIDA DEPARTMENT OF AGRICULTURE AND CONSUMER SERVICES DIVISION OF THE PLANT INDUSTRY.


 ALL SHRUBS, AND GROUNDCOVERS SHALL BE GUARANTEED FOR 90 DAYS FROM DATE OF FINAL ACCEPTANCE. ALL TREES AND PALMS SHALL BE GUARANTEED FOR SIX MONTHS FROM DATE OF FINAL ACCEPTANCE.

• LANDSCAPE CONTRACTOR SHALL LOCATE AND VERIFY ALL UNDERGROUND UTILITIES PRIOR TO DIGGING.



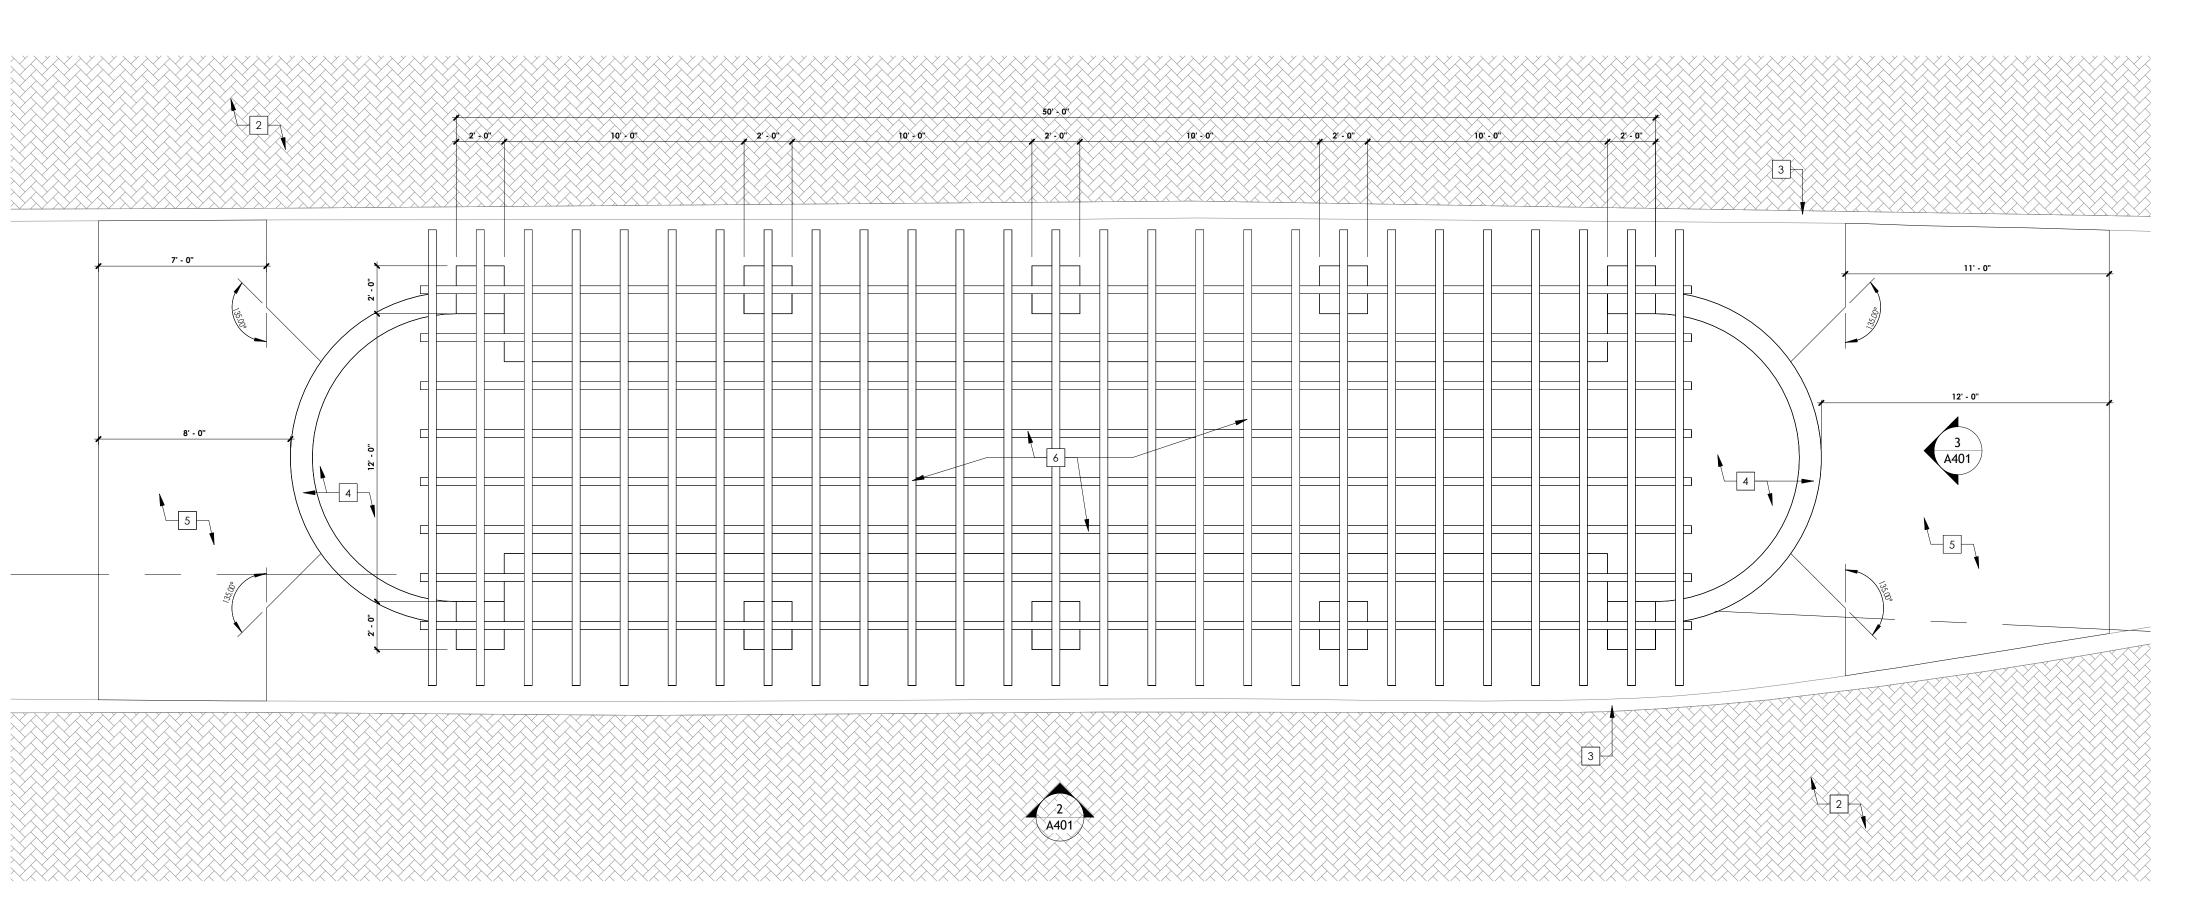

ROOF PLAN\_TRELLIS

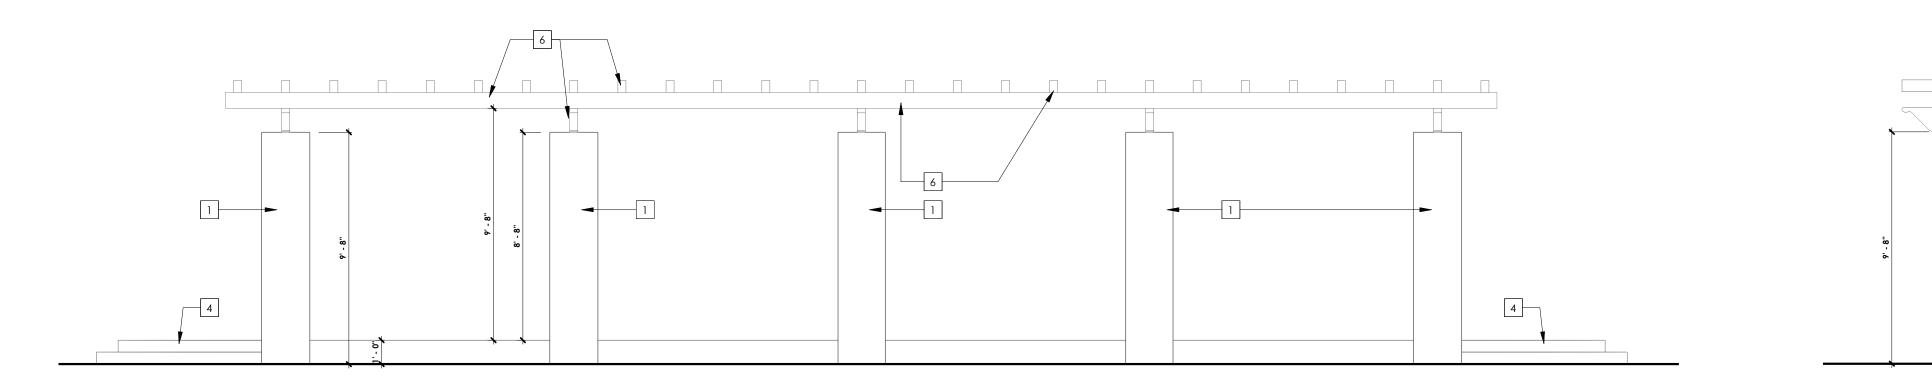




# NOTES

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- ALL LIGHTS FIXTURES TO BE SELECT BY OWNERS AND INSTALLED BY GENERAL CONTRACTOR
- TRELLIS WORK UNDER A SEPARATE PERMIT



# **KEY NOTES**

- 1 SMOOTH STUCCO FINISH
- 2 NEW CONCRETE PAVERS ROAD
- 3 CONCRETE CURB TO BE REPAIRED OR REPLACED AS NEEDED
- 4 EXISTING CONCRETE FINISH FLOOR TO REMAIN
- 5 NEW CONCRETE FINISHED WALKWAY
- 6 PROVIDE EXTERIOR PAINT FOR EXISTING AND REPLACED WOOD MEMBERS (TYPICAL)

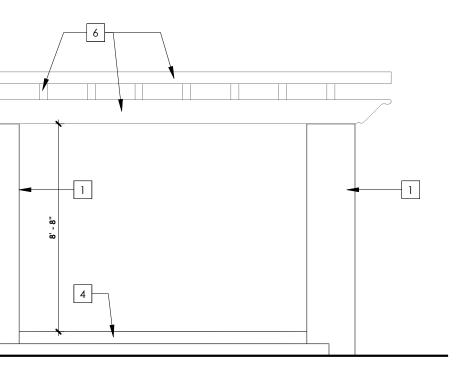

# EAST ELEVATION\_TRELLIS SCALE: 1/4" = 1'-0"

